



N.T.S

PROPOSED PAVEMENT CONSTRUCTION:

#### PARKING AREAS:


5" PCC WITH MIN. 28 DAY COMPRESSIVE STRENGTH OF 3500 PSI. REINFORCING STEEL #3 BARS SPACED AT 18" O.C.E.W.. PLACED ON TOP OF MIN. 6" DEPTH OF 6% BY VOLUME LIME STABILIZED SUBGRADE COMPACTED TO 95 PERCENT STANDARD PROCTOR DENSITY.

#### DRIVE/FIRELANES:

6" PCC WITH MIN. 28 DAY COMPRESSIVE STRENGTH OF 3500 PSI. REINFORCING STEEL #3 BARS SPACED AT 18" O.C.E.W.. PLACED ON TOP OF MIN. 6" DEPTH OF 6% BY VOLUME LIME STABILIZED SUBGRADE COMPACTED TO 95 PERCENT STANDARD PROCTOR DENSITY.

#### <u>DUMPSTER PAD:</u>

7" PCC WITH MIN. 28 DAY COMPRESSIVE STRENGTH OF 3500 PSI. REINFORCING STEEL #3 BARS SPACED AT 18" O.C.E.W.. PLACED ON TOP OF MIN. 6" DEPTH OF 6% BY VOLUME LIME STABILIZED SUBGRADE COMPACTED TO 95 PERCENT STANDARD PROCTOR DENSITY.

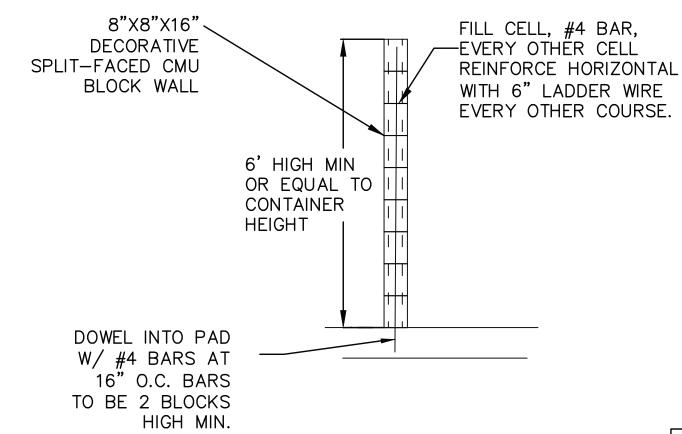

SITE PLAN

SCALE: 1" = 20'

SECTION A - A

DUMPSTER ENCLOSURE DETAIL

OWNER:
PMC CHASE LLP. -DFW METRO SOUTH
2800 PARK DRIVE SUITE 100
ARLINGTON TX 76015
STEVE TURNBOW, CCFC DIRECTOR
817-461-7439

ENGINEER:
AME ENGINEERING, INC.
4401 LITTLE RD STE 550 BOX 299
ARLINGTON TX 76016

JESSICA KILGORE, P.E. 817-583-7623

2620 W. IH-20

DIMENSIONAL CONTROL

AT PRAIRIE RIDGE
2620 W. IH-20
GRAND PRAIRIE, TX 75052
CONTACT NAME: STEVE TURN
CONTACT COMPANY: PMC CH

CONTACT NAME: STEVE TURNBOW
CONTACT COMPANY: PMC CHASE LLP, 2800
PARKS DRIVE, STE 100, ARLINGTON, TX
CONTACT PHONE: 817-891-7823

AME PROJECT NUMBER: 1000
2009 IBC, 2009 IECC, 2008 NEC

	F	AME EN	
#	DATE	DESCRIPTION	817-583-7
$\triangle$	12-11-2014	PER CITY SUP COMMENTS	
			FAX: 855-352-7689 4401 LITTLE RD SI

# AME ENGINEERING, INC. 17-583-7623 | mail@ameengineer.com

THE SEAL APPEARING ON THIS DOCUMENT WAS AUTHORIZED BY JESSICA J. KILGORE, P.E. 106106 ON NOVEMBER 19, 2014

JESSICA J. KILGORE

106106

CENSE

ONAL

ONAL

& SITE PLAN


SHEET NUMBER

C I

CASE NUMBER SU150102/S150102

;, INC. 817-583-7623 mail@am 00 PUBLISHED 12/10/2014. SOUTH ELEVATION (PRIMARY)

SCALE: 1/4" = 1'-0"

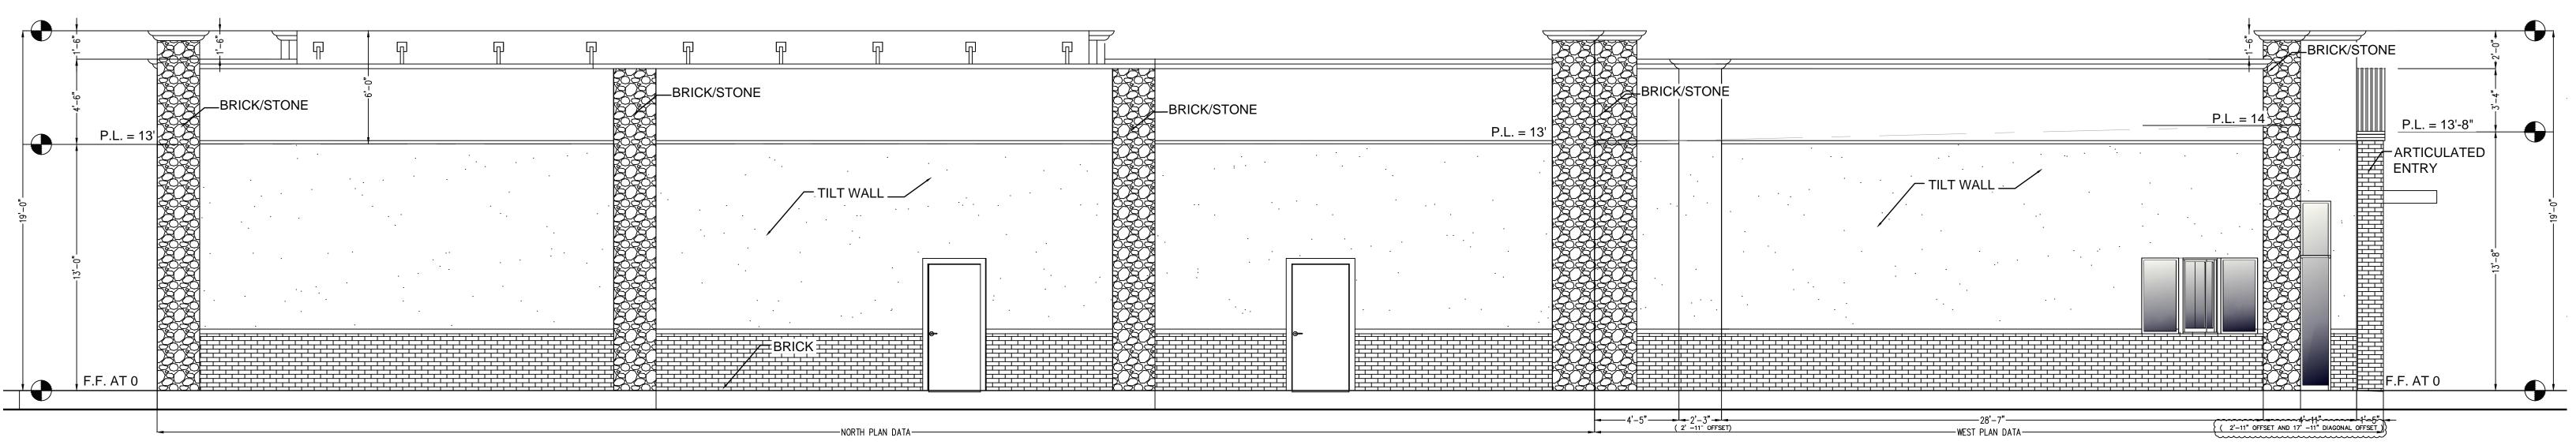

NORTH ELEVATION

SCALE: 1/4" = 1'-0"

ELEVATION PLAN DATA						
FACADE	TOTAL AREA (X)	OPENING AREA (Y)	PRIMARY MASONRY AREA (P)	SECONDARY MASONRY AREA (S)	PERCENTAGE PRIMARY (P/(X-Y)) 100	PERCENTAGE SECONDARY (S/(X-Y)) 100
NORTH	1372	42	1330	0	100	0
SOUTH	989	430	559	0	100	0
EAST	658	201	457	0	100	0
WEST	1503	196	1310	0	100	0

A 1 ELEVATIONS
SCALE: AS SHOWN

2620 W. IH-20
AT PRAIRIE RIDGE
2620 W. IH-20
GRAND PRAIRIE, TX 75052
CONTACT NAME: STEVE TURNBOW
CONTACT COMPANY: PMC CHASE LLP, 2800
PARKS DRIVE, STE 100, ARLINGTON, TX
CONTACT PHONE: 817-891-7823
AME PROJECT NUMBER: 1000

2009 IBC, 2009 IECC, 2008 NEC

PMC CHASE LLP. -DFW METRO SOUTH 2800 PARK DRIVE SUITE 100

STEVE TURNBOW, CCFC DIRECTOR 817-461-7439

AME ENGINEERING, INC. 4401 LITTLE RD STE 550 BOX 299 ARLINGTON TX 76016

ARLINGTON TX 76015

JESSICA KILGORE, P.E. 817-583-7623


ENGINEER:

REVISIONS						
#	DATE	DESCRIPTION				
Â	12-11-2014	PER CITY SUP COMMENTS				

### AME ENGINEERING, INC.

817-583-7623 | mail@ameengineeringinc.com

THE SEAL APPEARING ON THIS DOCUMENT WAS AUTHORIZED BY JESSICA J. KILGORE, P.E. 106106 ON NOVEMBER 19, 2014

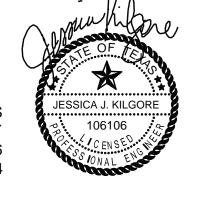


SHEET NUMBER

1

CASE NUMBER SU150102/S150102

ING, INC. 817-583-7623 mail@ameen

## MEST ELEVATION (PRIMARY) SCALE: 1/4" = 1'-0"

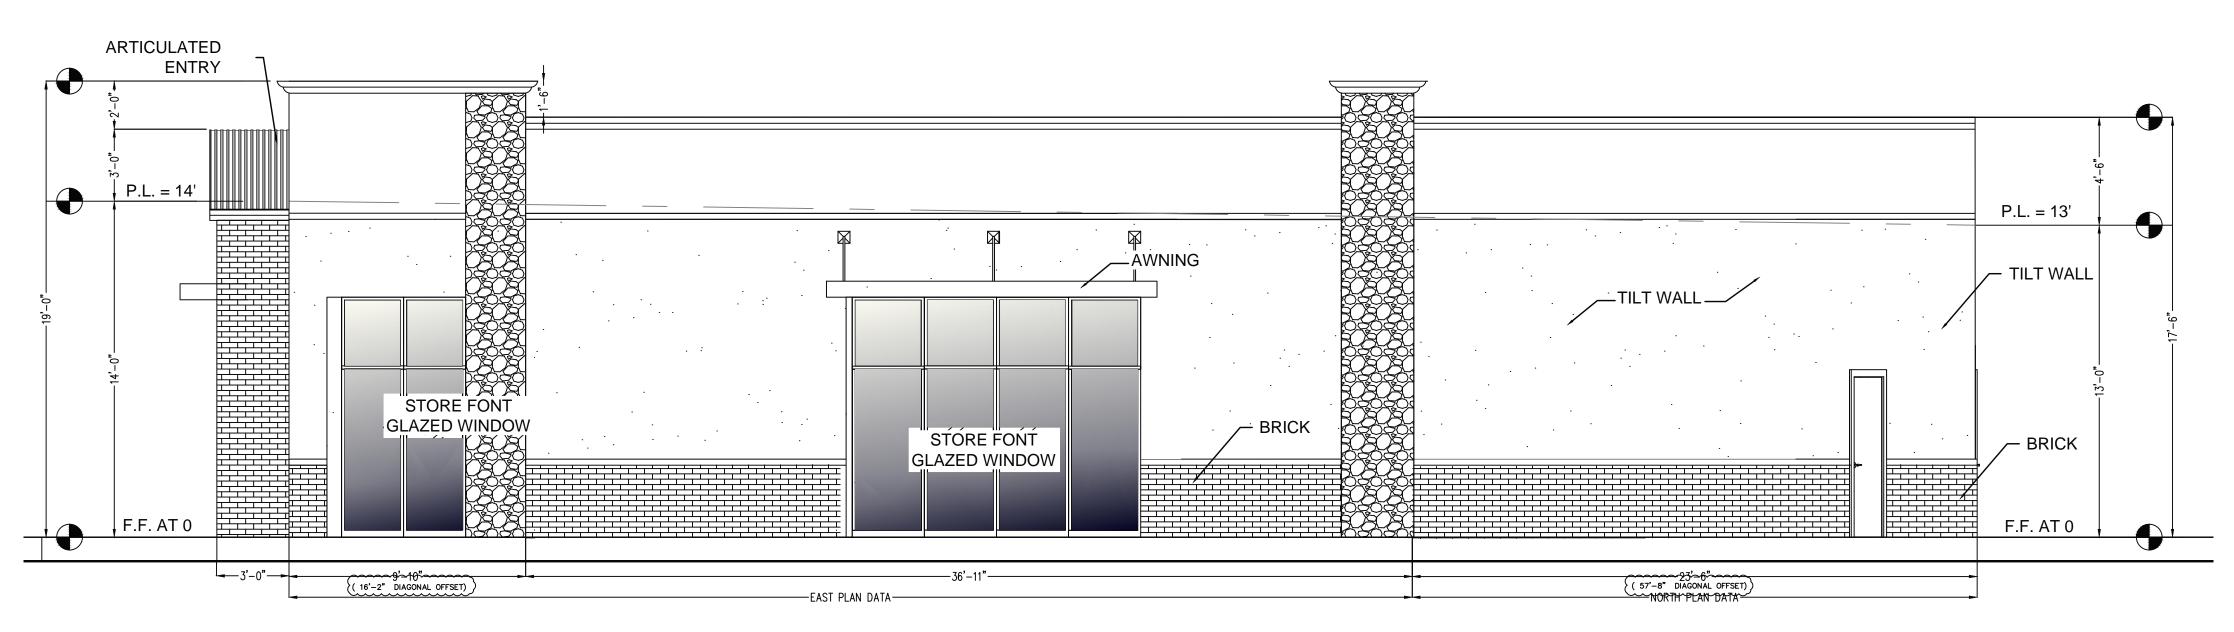

2 EAST ELEVATION
SCALE: 1/4" = 1'-0"

		ELEVAT	TON PL	AN DAT	A	
FACADE	TOTAL AREA (X)	OPENING AREA (Y)	PRIMARY MASONRY AREA (P)	SECONDARY MASONRY AREA (S)	PERCENTAGE PRIMARY (P/(X-Y)) 100	PERCENTAGE SECONDARY (S/(X-Y)) 100
NORTH	1372	42	1330	0	100	0
SOUTH	989	430	559	0	100	0
EAST	658	201	457	0	100	0
WEST	1503	196	1310	0	100	0

METAL
ROOF
P.L. = 13'-8"

AWNING
GLAZED
ENTRY


BRICK

BRICK

11'-9"
11'-5"
11'-5"
11'-5"
11'-5"
11'-5"
11'-5"
11'-1"

SIDE ELEVATION

FRONT ELEVATION

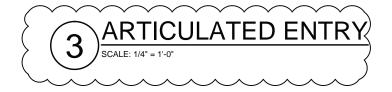

OWNER:
PMC CHASE LLP. -DFW METRO SOUTH
2800 PARK DRIVE SUITE 100
ARLINGTON TX 76015
STEVE TURNBOW, CCFC DIRECTOR
817-461-7439

ENGINEER:
AME ENGINEERING, INC.
4401 LITTLE RD STE 550 BOX 299
ARLINGTON TX 76016
JESSICA KILGORE, P.E.
817-583-7623

2620 W. IH-20
AT PRAIRIE RIDGE
2620 W. IH-20
GRAND PRAIRIE, TX 75052
CONTACT NAME: STEVE TURNBOW
CONTACT COMPANY: PMC CHASE LLP, 2800
PARKS DRIVE, STE 100, ARLINGTON, TX
CONTACT PHONE: 817-891-7823
AME PROJECT NUMBER: 1000

2009 IBC, 2009 IECC, 2008 NEC

A2ELEVATIONS
SCALE: AS SHOWN

AME	<b>ENGINE</b>	ERING,	INC.
817-5	83-7623 I	mail@ar	neengir

17-583-7623 | mail@ameengineeringinc.com


AX: 855-352-7689 401 LITTLE RD SUITE 550 BOX 299 RLINGTON, TX 76016 THE SEAL APPEARING ON THIS DOCUMENT WAS AUTHORIZED BY JESSICA J. KILGORE, P.E. 106106 ON NOVEMBER 19, 2014




SHEET NUMBER

CASE NUMBER SU150102/S150102


	F	REVISIONS
#	DATE	DESCRIPTION
λ	12-11-2014	PER CITY SUP COMMENTS

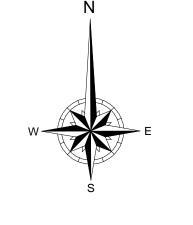

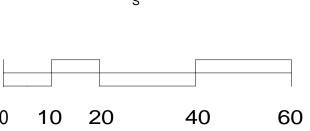

1" = 20'

## LANDSCAPE NOTES:

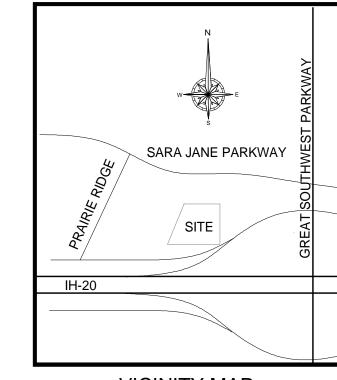

VICINITY MAP

N.T.S.

1. PLANT LIST TO BE USED AS AN AID TO BIDDER ONLY.

- 2. LANDSCAPE CONTRACTOR IS REPSONSIBLE FOR VERIFYING MATERIAL ESTIMATES. 3. ALL PLANT MATERIAL SHALL BE SUBJECT TO APPROVAL BY OWNER'S REPRESENTATIVE. 4. SEPARATE ALL TURF AND BED AREAS WITH 10 GAUGE STEEL EDGING UNLESS OTHERWISE NOTED.
- 5. FOLLOWING INSTALLATION OF STEEL EDGING, EXCAVATE AS NECESSARY TO REMOVE ALL PLANT MATERIAL, REMOVE ALL STONES AND DEBRIS 2" IN DIAMETER AND LARGER. ALL BEDS SHALL BE TILLED TO A DEPTH OF 4-6".
- 6. APPLY A 3" DEPTH OF BACKFILL MATERIAL OVER ENTIRE BED AREA AND TILL INTO EXISTING TOP 3" OF SOIL. BACKFILL MATERIAL SHALL BE COMPOSED OF ORGANIC MATERIAL SUCH AS LIVING EARTH TECHNOLOGY COMPOST OR APPROVED EQUAL.
- 7. INSTALL PLANTS AND ADD AGRIFORM PLANTING TABLETS (PER MANUFACTURER'S RECOMMENDED AMOUNT) TO ALL PLANTS ONE GALLON AND LARGER.
- 8. SLOPE ALL BEDS AT A 5% GRADE FROM CENTER OF BED OR FOUNDATION TO PERIMETER. 9. APPLY A PRE-EMERGENT HERBICIDE TO ALL BEDS AT MANUFACTURERS RECOMMENDED RATE. 10.TOP DRESS ENTIRE BED WITH A 2" LAYER OF SHREDDED HARDWOOD MULCH.
- 11.ALL SHADE AND ORNAMENTAL TREES SHALL BE PLANTED AS FOLLOWS: A) EXCAVATE SIDES OF PIT 24" LARGER THAN ROOT BALL AND SCARIFY SIDES B) EXCAVATE PIT TO SAME DEPTH AS ROOT BALL C) PLACE A 3" PERFORATED SEWER AND DRAIN PIPE AND CAP WRAPPED IN FILTER CLOTH AND SURROUND WITH 3/4-1" LIMESTONE 12" IN DIAMETER TO BASE OF PIT. D) BACKFILL SHALL CONSIST OF AN EQUAL MIXTURE OF EXISTING SOIL AND ORGANIC MATERIAL. E) FORM A TEMPORARY TREE WELL ON PERIMETER OF PIT AND TOP DRESS WITH A 2" LAYER OF HARDWOOD MULCH UP TO BUT NOT TOUCHING THE TRUNK OF TREE. F) FOLLOWING ONE YEAR GUARANTEE PERIOD TREE RING SHALL BE REMOVED. ALL TREES ARE TO BE STAKED SO TREE WILL NOT MOVE IN STRONG WINDS. STAKES WILL BE PLACED IN UNDISTURBED SOIL AT A
- MINIMUM DISTANCEOF 24" FROM EXCAVATED TREE PIT. 12.ALL TREES ARE TO BE STAKED AT TIME OF PLANTING UNLESS OTHERWISE NOTED. 13.PROVIDE A ONE YEAR GUARANTEE ON ALL PLANT MATERIAL FROM TIME OF ACCEPTED COMPLETION. FOLLOWING ONE YEAR GUARANTEE, OWNER AND LANDSCAPE CONTRACTOR SHALL WALK SITE, NOTE ANY MATERIALS TO BE REPLACED AND TIME PERIOD FOR REPLACEMENT. FOLLOWING GUARANTEE PERIOD, OWNER WILL SIGN OFF AND ACCEPT REPONSIBILITY FOR MAINTAINING HEALTH OF ALL LANDSCAPE MATERIAL.
- 14.ALL AREAS LABELED "TURF" SHALL BE COMMON BERMUDA HYDROMULCH UNLESS OTHERWISE NOTED. 15.REPAIR ALL DISTURBED AREAS ON JOB SITE AND ADJACENT SITE WITH COMMON BERMUDA OR ANNUAL
- RYE CONTINGENT UPON SEASON. 16.ALL LANDSCAPE AND TURF AREAS SHALL BE WATERED BY AN AUTOMATIC IRRIGATION SYSTEM WITH A RAIN AND FREEZE SENSOR WIRED TO CONTROLLER.
- 17.IRRIGATION SYSTEM SHALL BE DESIGNED AND INSTALLED ACCORDING TO THE TEXAS COMMISSION
- ON ENVIRONMENTAL QUALITY AND THE CITY OF GRAND PRAIRIE UNIFIED DEVELOPMENT CODE. 18. ALL DUMPSTER ENCLOSURES ARE TO HAVE AN 8' CMU WALL ON THREE SIDES AND OPAQUE DOORS ON
- 19. IF ANY SIDEWALKS ARE REQUIRED THEY WILL BE DESIGNED TO PROVIDE A HANDICAP ACCESS AT THE DRIVE APPROACHES.
- 20. OWNER IS REPSONSIBLE FOR THE MAINTENANCE AND OVERALL HEALTH OF THE LANDSCAPE. THIS SHALL INCLUDE, BUT NOT LIMITED TO, PRUNING, FERTILIZING, WATERING, MOWING, WEEDING AND OTHER SUCH ACTIVITIES NECESSARY FOR THE PROPER MAINTENANCE OF LANDSCAPING. 21. LEGEND IS AN AID FOR BIDDERS ONLY.

LANDSCAPE CALCULATIONS	REQUIRED	PROVIDED
REQUIRED LANDSCAPING PERCENTAGE REQUIRED LANDSCAPE SQUARE FOOTAGE	10% 3,890.80	11.33% 4,408
A MINIMUM OF 75% OF ALL REQUIRED LANDSCAPING SHALL BE LOCATED IN THE FRONT YARD BETWEEN THE BUILDING LINE AND THE PROPERTY LINE.	2,918.10	3,913
REQUIRED TREES - ONE TREE WITH A MINIMUM 3" TRUNK AND AT LEAST 6' IN HEIGHT FOR EVERY 500 SQUARE FEET OF REQUIRED LANDSCAPE AREA.	2,918.1 / 500 = 5.84	6
STREET TREES SHALL BE PLANTED A MINIMUM OF 25' APART AND A MAXIMUM OF 50' APART ALONG COLLECTOR AND ARTERIAL STREETS.	269.67 / 50 =5.39	5
PARKING LOT TREES SHALL BE LOCATED IN THE PARKING LOT AREA ONE TREE PER 20 PARKING SPACES.	44 / 20 = 2.2	2
PARKING SPACES SHALL BE LOCATED WITHIN 100' OF A TREE.	REQUIRED	PROVIDED
ONE SHRUB (MINIMUM OF 5 GALLON ) SHALL BE PROVIDED FOR EVERY 50 SQUARE FEET OF REQUIRED LANDSCAPE AREA.	3,890.80 / 50 = 77.82	87
SCREENING OF PUBLIC SPACES FROM PRIVATE LAND USE.	REQUIRED	PROVIDED



C. Thomas Fitzwilliam

ARLINGTON, TEXAS 76003-1626

LANDSCAPE ARCHITECT

TOM FITZWILLIAM

P.O. BOX 171626

817-437-3523

SITE SQUARE FOOTAGE - LOT 2RA - 38,908.00 GROSS SITE AREA - .89 Acre 38,908 SQUARE FEET COMMERCIAL ZONING REQUIRED LANDSCAPE PERCENTAGE - 5% 5% OF 40,213.18 = 2,010.659 SQ FT

OWNER:

CONTACT; STEVE TURNBOW TPS FAMILY LP 2800 PARK DRIVE ARLINGTON, TEXAS 76015 817-891-7823

ANDSC/ P.O. TON,

SERVIC

7600

8


REVISIONS:


10-17-2014 C10-37315


CHECKED BY: CTF

SCALE: 1" = 20.0'

SHEET:

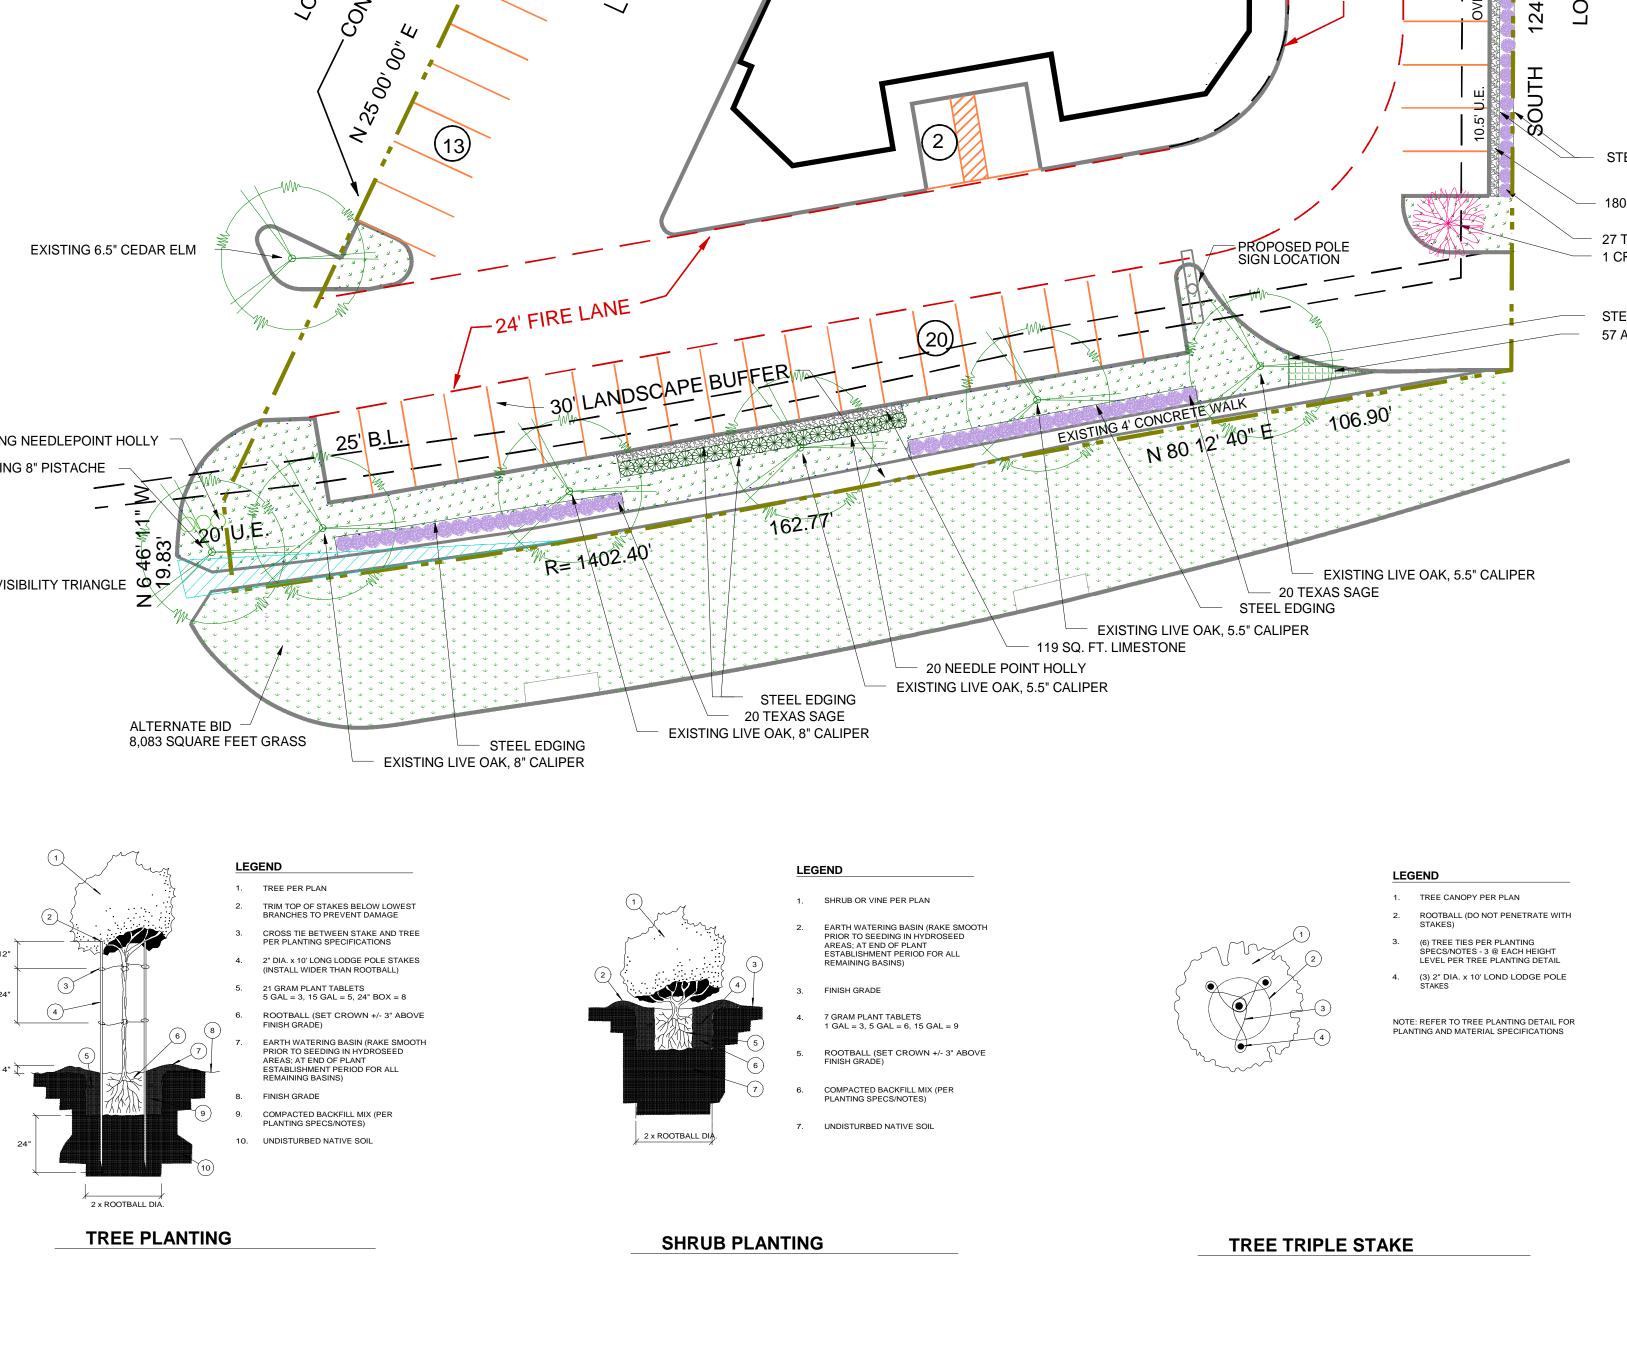

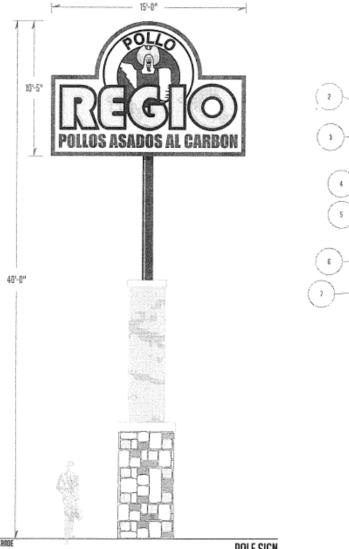

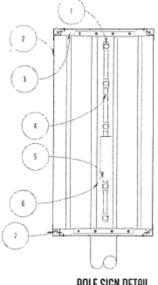

### POLE SIGN DETAIL SCALE: HTS

- 1 HIGH OUTPUT BRY LIGHT LAMPS IN SOCKET
  2 WHITE FLEX FRCE WITH TRANSLUCENT VINYL
  GARAPHICS
  3 ENGLED RILUMINUM FRAME
  4 1\* CONDUIT
  5 BRILARST
  6 LAMP RACEWAY
  7 CLIP AND ROD TEMSION SYSTEM

POLE SIGN SCRLE: 3/16" = 1"

	1965	PREMIELES
RUSSELL	10/20/2014 CLIENT EL POLLO REGIO	JKP
BYRUN	POLE SIGN LOCKTON	
SIGN	S 2520 W 1-20, GRAND PRARIE,	
972-291-07 RBSIGNS.NET		T IS PROHIBITED
1006 JOHNSON LAN	E. MIDLOTHIAN. TX 76065 • WWW.	RBSIGNS.NET

Street Parish v. pr. science and contract or feel and	RNELBOX, WITHIN SIX(G) FEET OF SIGNAGE. ALL I	PARTITION OF THE PARTITION OF T
BEFORE RPPROVING:		· · · · · · · · · · · · · · · · · · ·
	S CONTAINED IN THIS DRAWING, COLDES WILL!	
	N YOUR REQUEST. THERE MAY BE A FEE INVOLVE	
EDENTIFICATION AND PARTIES AND CONTRACTOR OF THE PROPERTY OF T	SIGHS WILL HOT BE HELD RESPONSIBLE FOR ANY Side this raproval. It is your responsibilit	
The consequence of the contract of the contrac		
-APPROVED AS IS	- APPROVED W/ HOTES	- DENIED, PLEASE REVISE
CLERT SIGNATURE	CLENT FROM	DATE
CHARLES AND ADMINISTRATION OF THE PARTY OF T	CENTERNATURE	
	L # 5 TL   T   1   1   1   1   1   1   1   1   1	TIGHTS